	File #	6-F	E-21-VA
	OF ZON	IING	APPEALS APPLICATION
Click on Meeting Schedule, Deadlines and Fees for informat	tion on submit	ting an	application to be heard at a monthly Board meeting
APPLICANT INFORMATION Name: Hudson Materials Company	APPLICA	NT IS:	THIS PROPOSAL PERTAINS TO: New Structure
Street Address: 1615 Sholar Avenue	Contractor	H	
City, State, Zip: Chattanooga, TN 37406	Tenant	V	Modification of Existing Structure Off Street Parking
Phone Number: 423-624-2631	Other	H	Signage
Email: GarrettG@hudsoncc.com			Other:
THIS IS	S A REQUES	T FOR	other
☐ Zoning Variance (Building Permit Denied) ☐ Appeal of Administrative Official's Decision	₽ E	xtensio	on of Non-Conforming Use/or Structure erpretation
PROPER	RTY INFORM		
Street Address : 405 West Oldham Avenue			City, State, Zip: Knoxville, TN 37917
See KGIS.org for Parcel #: 081NB034			and Zoning District: I-MU/F
	ICE REQUIR	EMEN	rs de maner de mandre de la company
City of Knoxville Zoning Ordinance Article 7, Section 2 The City of Knoxville Board of Zoning Appeals shall have the power and and under the restrictions set out in this section. The purpose of the variance is to modify the strict application of the sp shallow or steep lots, or other exceptional physical conditions, whereby which would deprive an owner of the reasonable use of his land. The vipreventing an owner from using his property as the zoning ordinance in	ecific requireme y such strict app ariance shall be	ents of th	nis ordinance in the case of exceptionally irregular, narrow,
	PTION OF A	PPEA	
Describe your project and why you need variances.			
The work associated with this variance would in would also remove but not replace 2 tanks. We replace all tank foundations, piping, gauges, an reconstructing the secondary containment (con	would add Id insulatio	5 ne n for a	w tanks. We would also remove and

The work associated with this variance would would also remove but not replace 2 tanks. W replace all tank foundations, piping, gauges, a reconstructing the secondary containment (concrete curb) on the north side of the plant to surround all tanks. We would also be installing a hot oil heating system that would replace the old electrical heating system that is currently in place. Hot oil heating ia much safer and more efficient heating system. The work associated with this variance in comparison from the very original site plan would add a net overall gain of one tank. The scope of work with this variance is very similar to our previous variance reqest. Our main objective is to upgrade our plant equipment with the latest technology and equipment available. This will reduce our energy consumption and make our facility safer and more efficient. Our business operations would be the same.

Describe hardship conditions that apply to this variance.

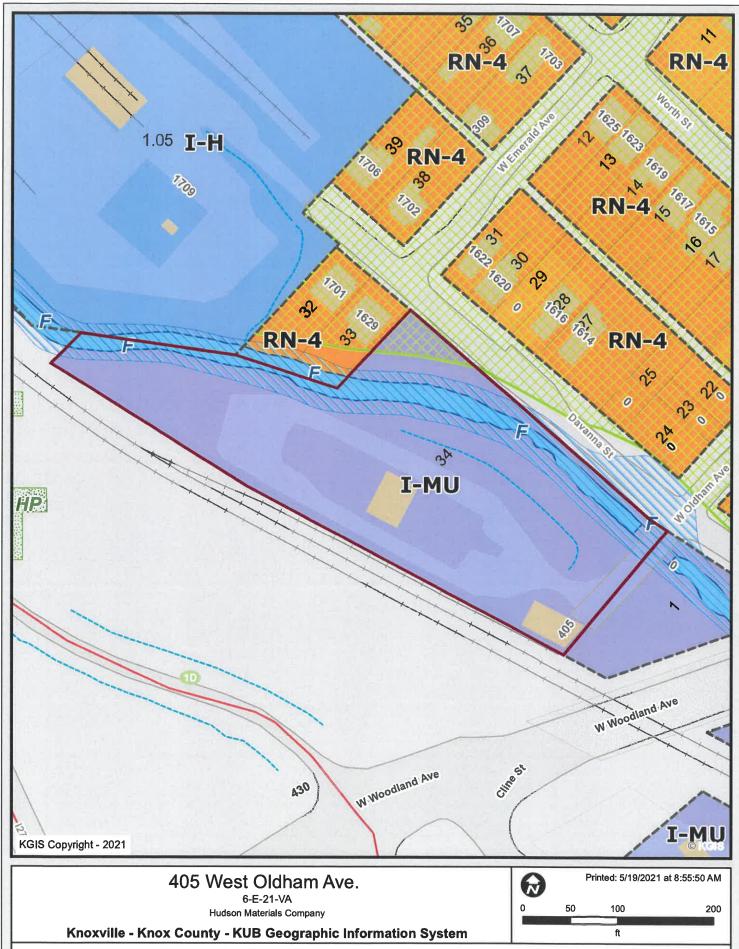
REVISED

We are unable to upgrade our facility due to being classfied as non-conforming use. We are not changing our business operations and the type of work that is done but are simply trying to upgrade the facility.

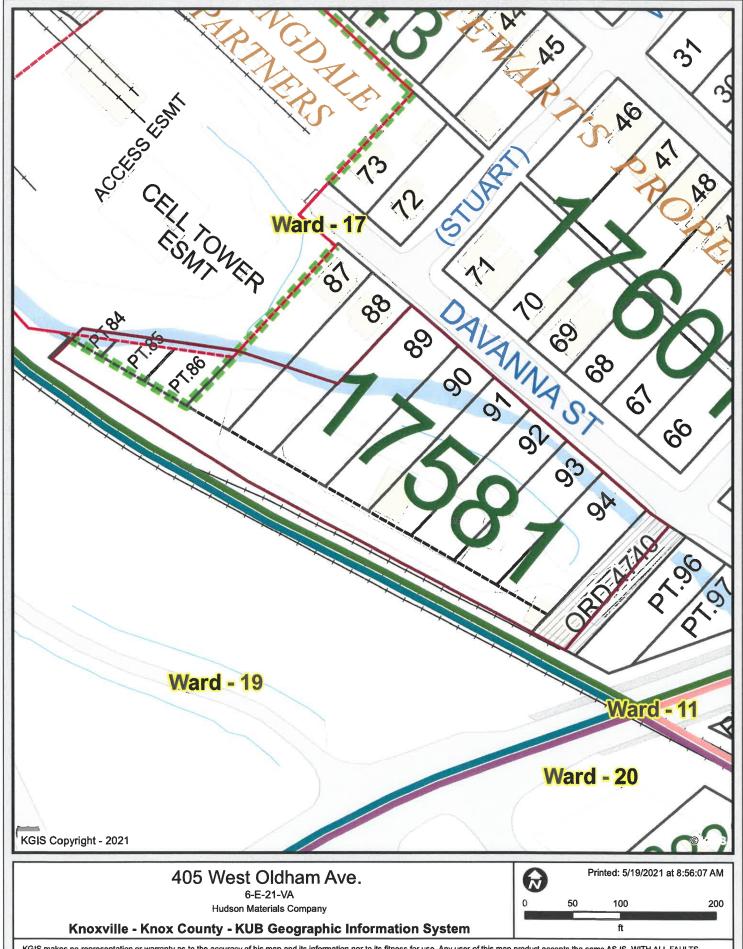
APPLICANT AUTHORIZATION

I hereby certify that I am the authorized applicant, representing A	LL property owners involved
in this request and that all owners have been notified of this reque	est in writing

	File #
CITY OF KNOXVILLE BO	ARD OF ZONING APPEALS APPLICATION
	FICE USE ONLY******
Is a plat required? Yes No	Small Lot of record?
VARIANCE REQUES	T(S) WITH ORDINANCE CITATION(S):
Date Filed	DJECT INFORMATION Fee Amount
Council District	BZA Meeting Date
PLANS REVIEWER	DATE



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405 West Oldham Ave.

6-E-21-VA Hudson Materials Company

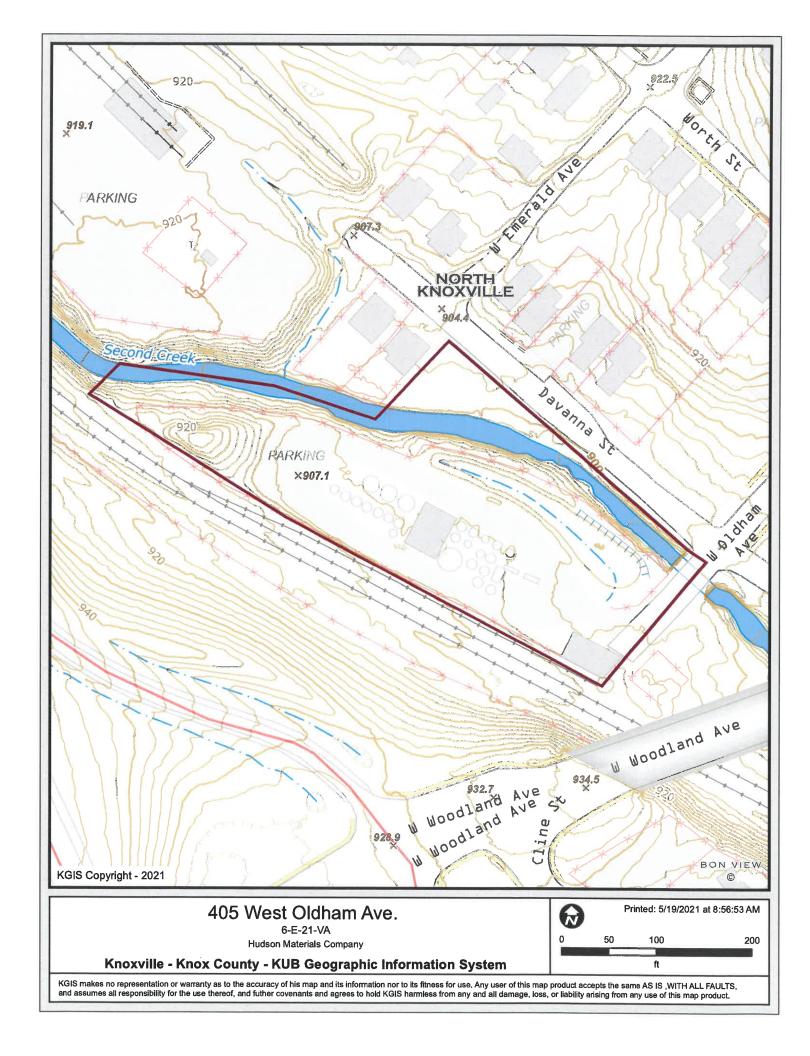
Knoxville - Knox County - KUB Geographic Information System

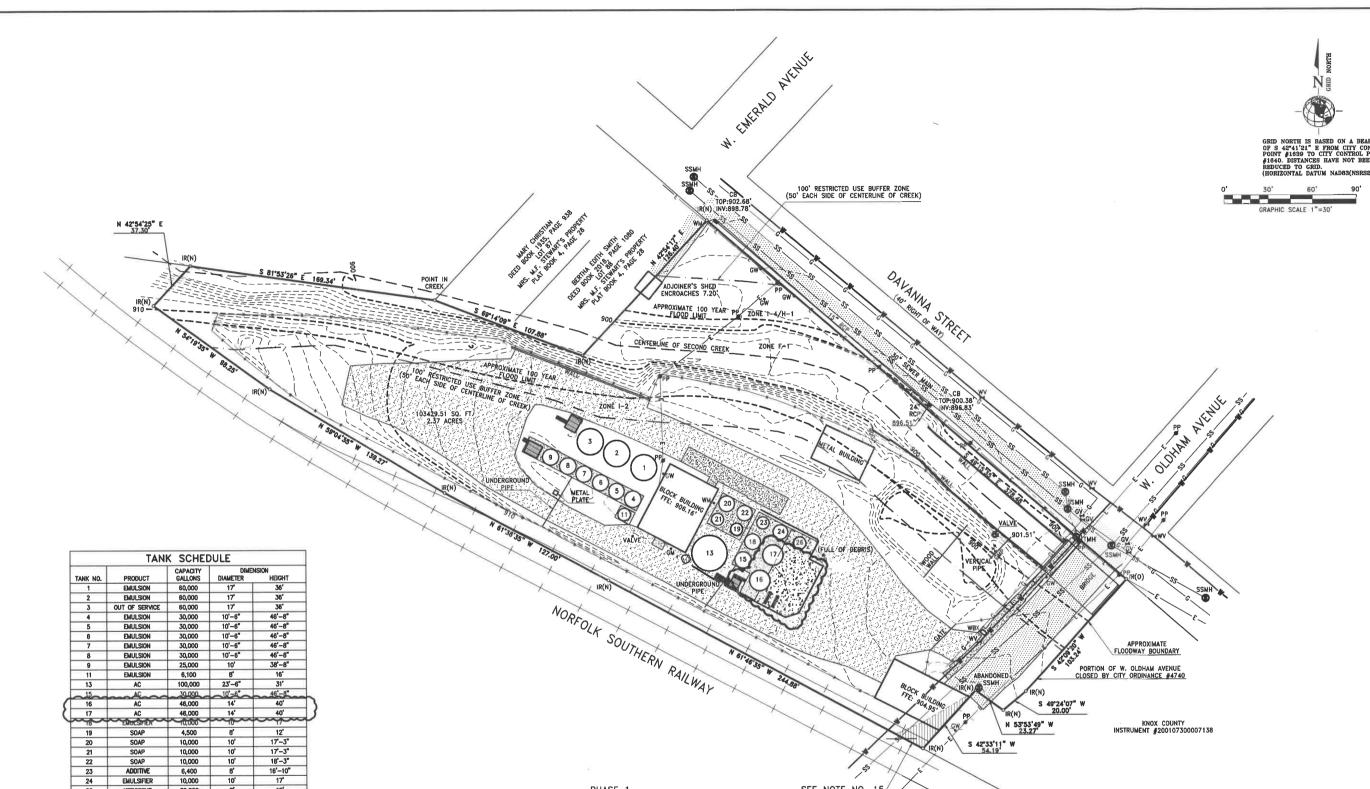
Printed: 5/19/2021 at 8:56:32 AM

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SEE NOTE NO. 15/

	LEGEND
	WOOD
	ASPHALT
	GRAVEL
100	CONCRETE
IR(0)	IRON ROD OLD
IR(N)	IRON ROD NEW
IP(O)	IRON PIPE OLD
PT	UNMONUMENTED POINT
⊯ PP	POWER POLE
⊯ LP	LIGHT POLE
∭ SP	SERVICE POLE
RCP	REINFORCED CONCRETE PIPE
CMP	CORRUGATED METAL PIPE
SDMH	STORM DRAIN MANHOLE
SSMH	SANITARY SEWER MANHOLE
СВ	CATCH BASIN
GW	GUY WIRE
WM	WATER METER
WV	WATER VALVE
GM	GAS METER
GV	GAS VALVE
EM	ELECTRIC METER
CO	CLEAN OUT
TPED	TELEPHONE PEDESTAL
WBX	WATER BOX
SOV	SHUT OFF VALVE
FH	FIRE HYDRANT
TMH	TELEPHONE MANHOLE
LI	NE LEGEND
_	PROPERTY LINE
——SS	DANIJAKI DENEK EIN
	ELECTRIC LINE
- G-	GAS LINE WATER LINE
T	TELEPHONE LINE
x	FENCE LINE

SCALE : AS NOTED

REFERENCE DRAWINGS	REVISIONS								
	NO.	DESCRIPTION	BY	DATE	CHI	ik. t	DATE	APPR.	DATE
	0	ISSUED FOR PERMIT	LWL	11/20/	/20				
	-1	UPDATED CONCRETE PAD	LWL	1/18/	/21				
	2	GENERAL UPDATE	L,WL	3/4/	/21				
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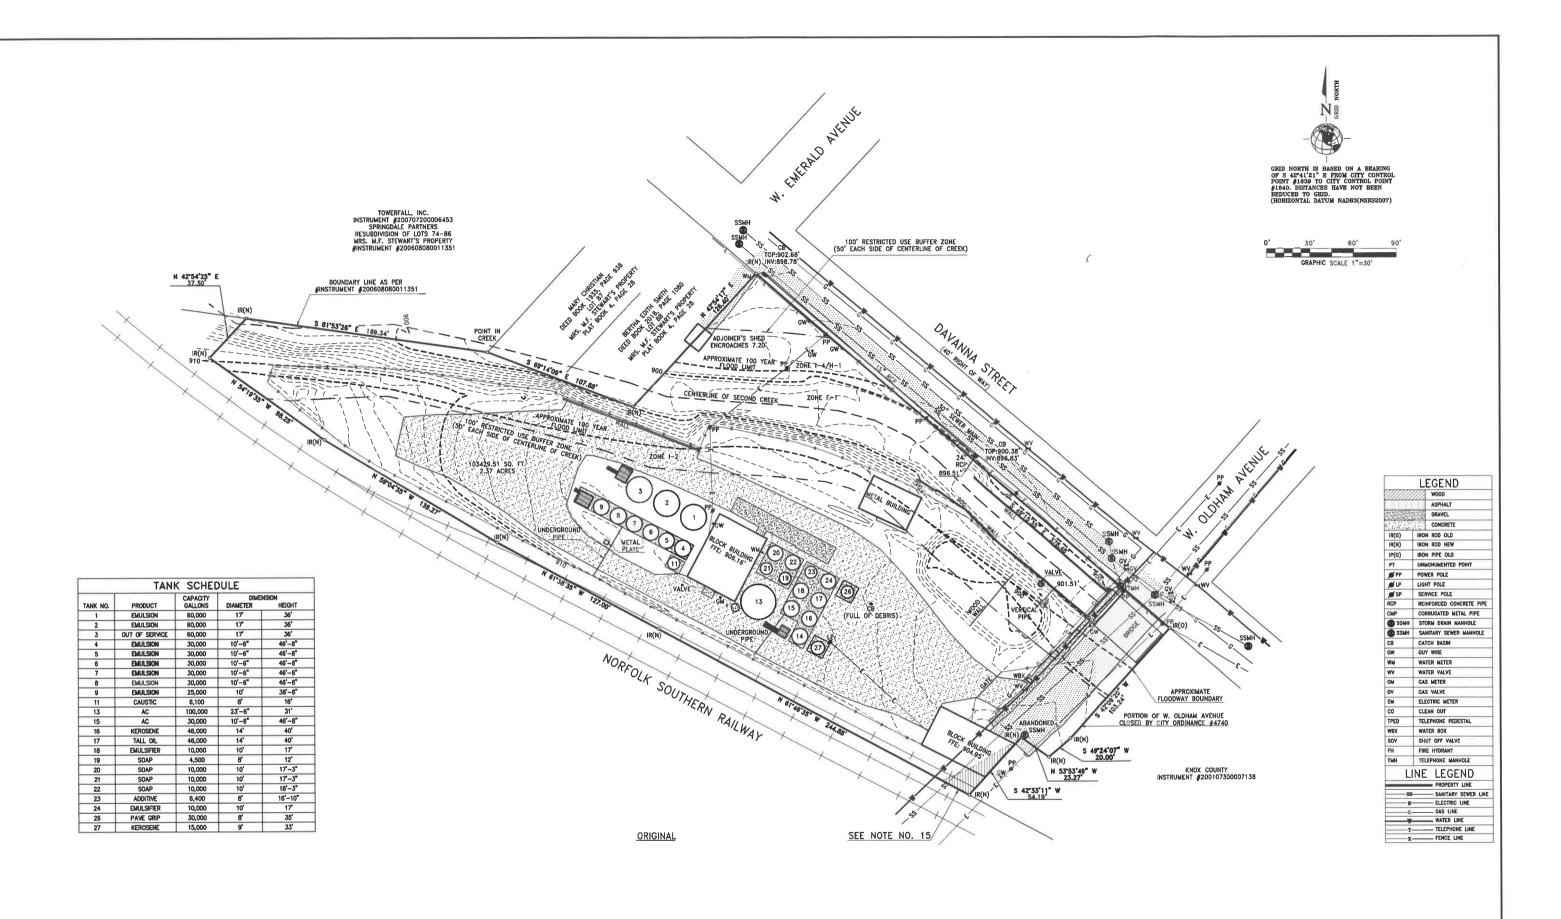
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PHASE 1



ISO	SERVICE	s	PROJECT HUDSON MATERIA	LS				
COCATION KNOXVILLE TN			PLOT PLAN					
DRAWN BY	DATE DRAWN	CAD FILE	DRAWING NO.	REV.				
LWL	11/20/20	C081002	C-081-002	2				



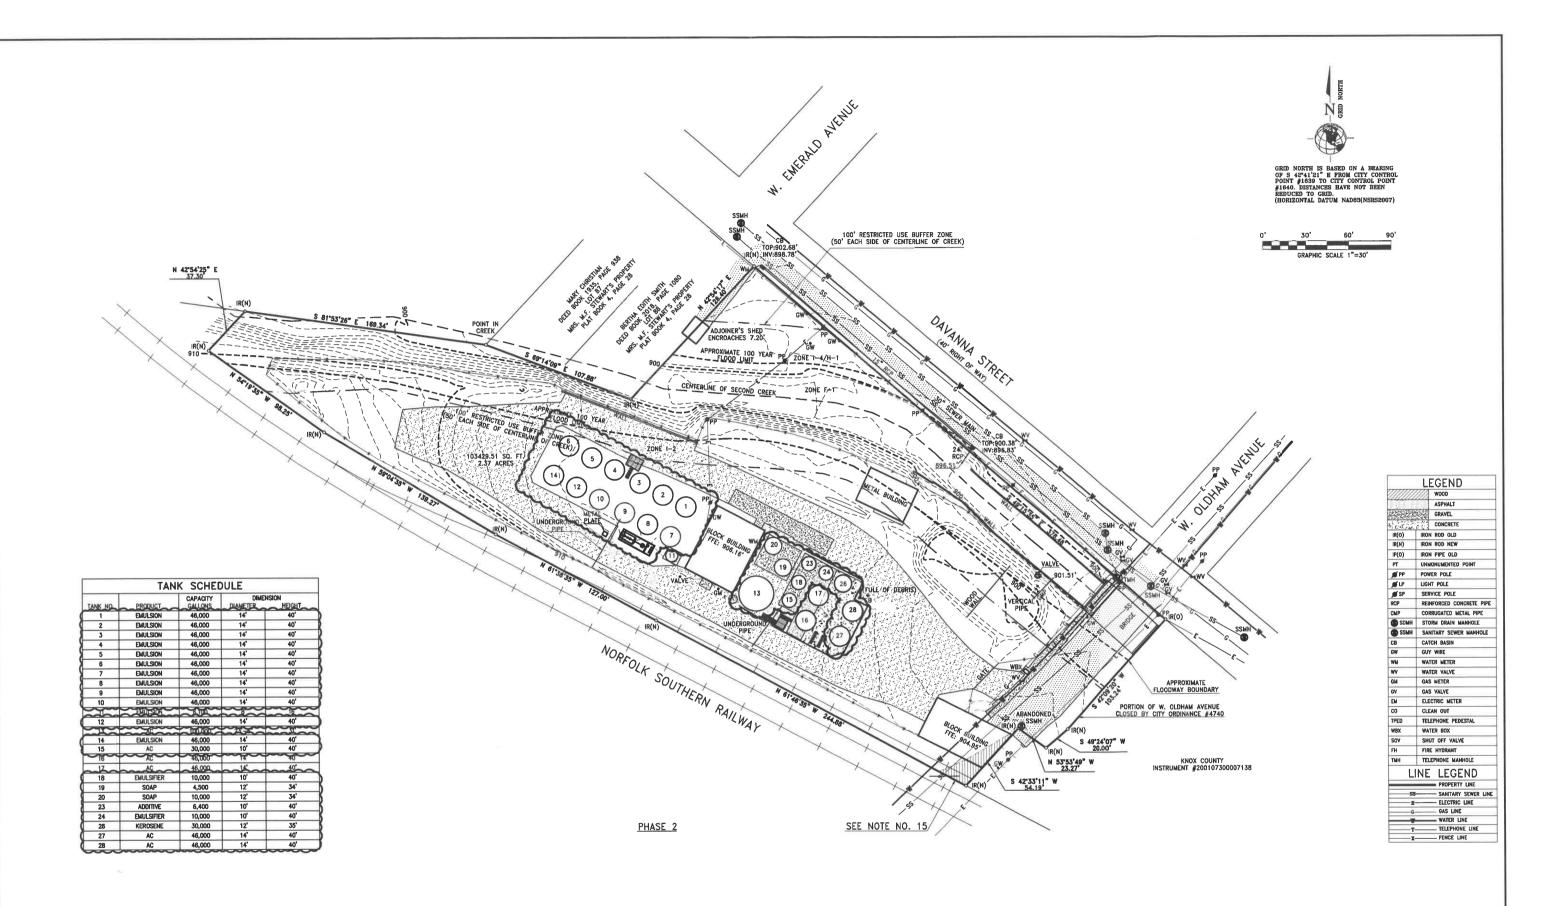
- 1			
	ME		

COMPANY ISO	SERVICE	s	PROJECT HUDSON MATER	IALS					
LOCATION KNO	XVILLE T	N	PLOT PLAN						
DRAWN BY	DATE DRAWN	CAD FILE	DRAWING NO.	REV.					
LWL	11/20/20	C081001	C-081-001	0					

SCALE : AS NOTED

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SCALE	:	AS	NOTE

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1	COMPANY			PROJECT							
ı	ISO	SERVICES	S	HUDSON MATERIALS							
ı	LOCATION			DRAWING TITLE							
	KNO	XVILLE T	N	PLOT PLAN							
ı	DRAWN BY	DATE DRAWN	CAD FILE	DRAWING NO.	REV.						
	LWL	11/20/20	C081003	C-081-003	3						

FW: Variance Application for 405 West Oldham Avenue Knoxville TN

Juliana LeClair <JLeClair@knoxvilletn.gov>

Mon 5/24/2021 11:28 AM

To: Cheri Burke <cmburke@knoxvilletn.gov>

6 attachments (4 MB)

Revised Variance App #2.pdf; Final Plot Plan.pdf; Original Plot Plan.pdf; Plot Plan Variance 1.pdf; Current Tank Appearance.jpg; Future Tank Appearance.jpg;

From: Scott Elder <selder@knoxvilletn.gov>

Sent: Friday, May 21, 2021 3:30 PM

To: Juliana LeClair < JLeClair@knoxvilletn.gov>

Subject: FW: Variance Application for 405 West Oldham Avenue Knoxville TN

Juliana,

Here is the revised application for 6-E-21-VA along with attachments. I think you can just replace the original submittal with this one.

SE

From: Garrett Guiles <garrettg@hudsoncc.com>

Sent: Friday, May 21, 2021 1:27 PM To: Scott Elder <selder@knoxvilletn.gov>

Subject: Re: Variance Application for 405 West Oldham Avenue Knoxville TN

Scott,

Attached is a revised application describing the scope of work specifically for this variance request. I have provided all other attachments (original plot plan, variance 1 plot plan and the final plot plan) as well as current appearance of tanks and the future appearance. The information below regarding tank numbers is specifically for this variance request (#2). I appreciate your guidance and help to make sure we are providing accurate and detailed information for the boards review. Please don't hesitate to reach out if I can help further explain or describe our intentions for this variance.

Thanks!

-Garrett

Knoxville Board of Zoning Appeals,

Please see the attached documents and photographs illustrating our plans for upgrades at our Knoxville facility. A few of the pictures are of our actual tanks that currently exist and as you can see, they are in rough shape. The picture of the black tank(s) and the sample panel of insulation is what the outside of the new tanks will look like. These investments will improve the overall efficiency of our facility regarding energy consumption, air quality, water protection and the safety of our employees and

customers visiting this site. These upgrades will also allow us to create a few more jobs and add additional employment at this location. I have also supplied a current site plan, site plan for variance 1 and the proposed final site plan which illustrates the removal and replacement of the tanks that I have outlined below. In addition, all our proposed construction will be approved through the City of Knoxville **Building Permitting Office.**

Removal:

Tanks 1,2,3,4,5,6,7,8,9,13,15,18,19,20,21,22,23,24,26

Replacement:

Tanks 1,2,3,4,5,6,7,8,9,13,15,18,19,20,23,24,26

Add:

Tanks 10,12,14,27,28

Existing Tank Height: 47 ft

Replacement Tank Height: 40-45 ft Added Tank Heights: 40-45 ft

We appreciate the consideration of the BZA of our application and our hopeful we will be granted variances to complete these much-needed upgrades to our facility. Obtaining this variance would allow us to upgrade our facility with the latest technology and equipment available. It would be our intention to complete these upgrades in a timely manner over the next few years and through the proper channels with the City of Knoxville Building Permitting Office. We appreciate your time and review of our application.

Sincerely,

Garrett

From: Scott Elder <selder@knoxvilletn.gov> Sent: Friday, May 21, 2021 12:29 PM

To: Garrett Guiles <garrettg@hudsoncc.com>

Subject: RE: Variance Application for 405 West Oldham Avenue Knoxville TN

Garrett,

As point of clarification, can you explain the work associated only with this variance? In other words, how many tanks are being removed and how many are being replace in this phase only? Also, it appears that the footprint is being expanded on the north end to accommodate the new tanks (concrete slab). The language in your application seems to be exactly the same as the first variance application, however the work is somewhat different. It will be important that the application reflect exactly what's taking place on the site. If the language does not match the plans, this could cause confusion for the board and result in a postponement or even denial.

Please update the "Description of Appeal" section of the application to reflect what is shown on the plans. As a rule, more information is always better.

Let me know if you have questions.

Thank-you,

Scott Elder, Zoning Chief City of Knoxville Plans Review and Inspections 865 215 4473 office selder@knoxvilletn.gov www.knoxvilletn.gov

From: Garrett Guiles <garrettg@hudsoncc.com> Sent: Wednesday, May 19, 2021 8:25 AM To: Scott Elder <selder@knoxvilletn.gov>

Subject: Re: Variance Application for 405 West Oldham Avenue Knoxville TN

Scott,

Thanks for reaching out. Yes, your calculations are correct. Similar to our first variance application our main goal is to remove the old tanks and assets we have and upgrade with new ones. This will make our a more efficient operation in many ways as well as safer and enhance the appearance of our facility.

I am happy to answer any other questions you or the board might have regarding this application.

The three plot plans that I attached originally show the original plan, the plan after we complete the project that we applied for on the first variance and the end result for this new application. We will be conducting the same business as we have in the past 30 some years here but our plant is outdated and needs to be updated with current technology and safety features. Please don't hesistate to reach out if I can explain our intentions in more detail.

Thanks!

Garrett



Garrett Guiles Hudson Materials Company (c) 423-802-0285

(o) 423-624-2631

From: Scott Elder <selder@knoxvilletn.gov> Sent: Tuesday, May 18, 2021 11:58 AM To: Garrett Guiles <garrettg@hudsoncc.com>

Subject: FW: Variance Application for 405 West Oldham Avenue Knoxville TN

Good morning Garrett.

I was going over your BZA application this morning and was trying to piece together the number of tanks that were out there originally vs. how many remained after phase I, then finally phase II.

By my count I have:

Originally: 24 tanks Phase I: 22 tanks Phase II: 25 tanks

A net overall gain of 1 tank. Is this correct?

I think your explanations are very good and will help the board understand what's happening on the site and why. I'd like to be able to present them with an overall tank count that illustrates what has taken place from start to finish. I think that would be a simple way for them to understand the total change in the site. Is that something you can provide?

Thank-you,

Scott Elder, Zoning Chief City of Knoxville Plans Review and Inspections 865 215 4473 office selder@knoxvilletn.gov www.knoxvilletn.gov

From: Garrett Guiles <garrettg@hudsoncc.com>

Sent: Tuesday, May 11, 2021 9:09 AM

To: Bryan Berry < BBerry@knoxvilletn.gov>; Juliana LeClair < JLeClair@knoxvilletn.gov>

Subject: Variance Application for 405 West Oldham Avenue Knoxville TN

Knoxville Board of Zoning Appeals,

Please see the attached documents and photographs illustrating our plans for upgrades at our Knoxville facility. A few of the pictures are of our actual tanks that currently exist and as you can see, they are in rough shape. The picture of the black tank(s) and the sample panel of insulation is what the outside of the new tanks will look like. These investments will improve the overall efficiency of our facility regarding energy consumption, air quality, water protection and the safety of our employees and customers visiting this site. These upgrades will also allow us to create a few more jobs and add additional employment at this location. I have also supplied a current site plan, site plan for variance 1 and the proposed final site plan which illustrates the removal and replacement of the tanks that I have outlined below. In addition, all our proposed construction will be approved through the City of Knoxville **Building Permitting Office.**

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Existing Tank Height: 47 ft

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We appreciate the consideration of the BZA of our application and our hopeful we will be granted variances to complete these much-needed upgrades to our facility. Obtaining this variance would allow us to upgrade our facility with the latest technology and equipment available. It would be our intention to complete these upgrades in a timely manner over the next few years and through the proper channels with the City of Knoxville Building Permitting Office. We appreciate your time and review of our application.

Sincerely,

Garrett



Garrett Guiles President **Hudson Materials Company** (c) 423-802-0285 (o) 423-624-2631

